GENERAL LEGEND

PROPOSED PROPERTY LINES SETBACK LINES mm. STONEWALL BARBED WIRE _____ AQUIFER PROTECTION LINE FLOOD PLAIN LINE MAJOR CONTOUR EDGE OF PAVEMENT
VERTICAL GRANITE CURB
SLOPE GRANITE CURB
CAPE COD BERM POURED CONCRETE CURB SILT FENCE DRAINAGE LINE SEWER LINE SEWER FORCE MAIN WATER LINE WATER SERVICE OVERHEAD ELECTRIC UNDERGROUND ELECTRIC

> _ 100.00 BENCHMARK (TBM)

XXXXX 959595

帝帝帝

100x0

× 100.00

@TP1

RETAINING WALL

CENTERLINE FRESHWATER WETLANDS LINE

UNDERDRAIN
FIRE PROTECTION LINE
THRUST BLOCK IRON PIPE/IRON ROD
DRILL HOLE
IRON ROD/DRILL HOLE
STONE/GRANITE BOUND
SPOT GRADE

PAVEMENT SPOT GRADE

DOUBLE POST SIGN WELL TEST PIT FAILED TEST PIT

PHOTO LOCATION TREES AND BUSHES DRAIN MANHOL SEWER MANHOLE

WATER SHOT OFF
REDUCER
SINGLE GRATE CATCH BASIN
DOUBLE GRATE CATCH BASIN
TRANSFORMER
CULVERT W/MINGWALLS
CULVERT W/ELARED END SECTION
CULVERT W/STRAIGHT HEADWALL

4K SEPTIC AREA WETLAND IMPACT

VEGETATED FILTER STRIP RIPRAP

OPEN WATER FRESHWATER WETLANDS

STABILIZED CONSTRUCTION


CONCRETE GRAVEL


COMMERCIAL SITE PLAN

"VENTURE POWERSPORTS" **TAX MAP 220, LOT 50** 7 TOLEND ROAD, BARRINGTON, NH

SHEET INDEX

COVER SHEET EXISTING CONDITIONS PLAN C1 C2 SITE PLAN GRADING AND DRAINAGE PLAN C3 C4 UTILITY PLAN LIGHTING PLAN L1 LANDSCAPE PLAN 12 **DETAIL SHEET** D₁ FLOOR PLAN A1 ARCHITECTURAL ELEVATIONS A2 **EROSION AND SEDIMENT CONTROL DETAILS**

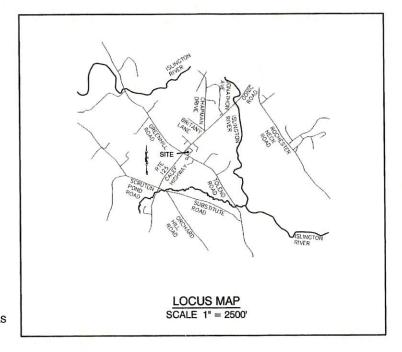

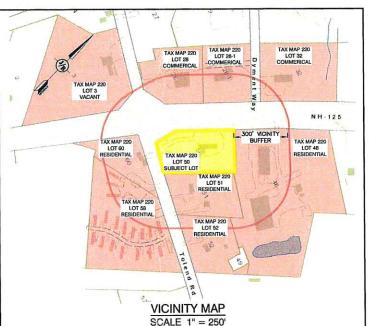

CIVIL ENGINEER / SURVEYOR JONES & BEACH ENGINEERS, INC. **85 PORTSMOUTH AVENUE**

PO BOX 219 STRATHAM, NH 03885 (603) 772-4746 CONTACT: JOSEPH CORONATI EMAIL: JCORONATI@JONESANDBEACH.COM

WETLAND CONSULTANT GOVE ENVIRONMENTAL SERVICES, INC. 8 CONTINENTAL DR., BUILDING 2, UNIT H EXETER, NH 03833-7526 (603) 778-0644 CONTACT: JAMES GOVE

NOTES (3.2.10)

PURPOSE OF PLAN: SEE SHEET C2 TAX MAP 220, LOT 50 AREA OF SUBJECT PARCEL: SEE BELOW ZONING DESIGNATION: SEE SHEET C1 ZONING REQUIREMENTS: SEE SHEET C1 EXISTING USE: RECREATIONAL PROPOSED USE: SEE SHEET C2 PARKING REQUIREMENTS: SEE SHEET C2 LOT COVERAGE: SEE SHEET C2 SANITARY SEWER SOURCE: ON-SITE SEPTIC SYSTEM WATER SUPPLY SOURCE: ON-SITE WELL ZONING VARIANCES: NONE FLOODPLAIN INFORMATION: SEE SHEET C1 STATE PERMITS REQUIRED: NONE PLANNING BOARD WAIVERS: NONE REQUESTED

- IF DURING CONSTRUCTION, IT BECOMES APPARENT THAT DEFICIENCIES EXIST IN THE APPROVED DESIGN DRAWINGS THE OWNER SHALL BE REQUIRED TO CORRECT THE DEFICIENCIES TO MEET THE REQUIREMENTS OF THE REGULATIONS AT NO EXPENSE TO THE TOWN.
- IF, DURING CONSTRUCTION, IT BECOMES APPARENT THAT ADDITIONAL EROSION CONTROL MEASURES ARE REQUIRED TO STOP ANY EROSION ON THE CONSTRUCTION SITEDUE TO ACTUAL SITE CONDITIONS, THE OWNER SHALL BE REQUIRED TO INSTALL THE NECESSARY EROSION PROTECTION AT NO EXPENSE TO THE TOWN.
- ALL MATERIALS AND METHODS OF CONSTRUCTION SHALL CONFORM TO TOWN REGULATIONS AND THE LATEST EDITION OF THE NEW HAMPSHIRE DEPARTMENT OF TRANSPORTATION'S STANDARD SPECIFICATIONS FOR ROAD

EVERSOURCE 74 OLD DOVER ROAD ROCHESTER, NH 03867 (603) 332-4227

FAIRPOINT COMMUNICATIONS USE OFFICE

SOMERWORTH, NH 03878 ATTN:DAVE KESTNER (603) 743-1114

PLANNING BOARD APPROVAL BLOCK

CABLE TV

METROCAST CORPORATION 21 JARVIS AVE. ROCHESTER, NH 03868 (603) 335-4106

17 DUDLEY ROAD, BRENTWOOD, NH 03833 BK 4855 PG 0723

Checked: JAC | Scale: AS NOTED | Project No.: 20656.1 Drawing Name: 20656-PLAN.dwg THIS PLAN SHALL NOT BE MODIFIED WITHOUT WRITTEN RMISSION FROM JONES & BEACH ENGINEERS, INC. (JBE). ANY ALTERATIONS, AUTHORIZED OR OTHERWISE, SHALL BE

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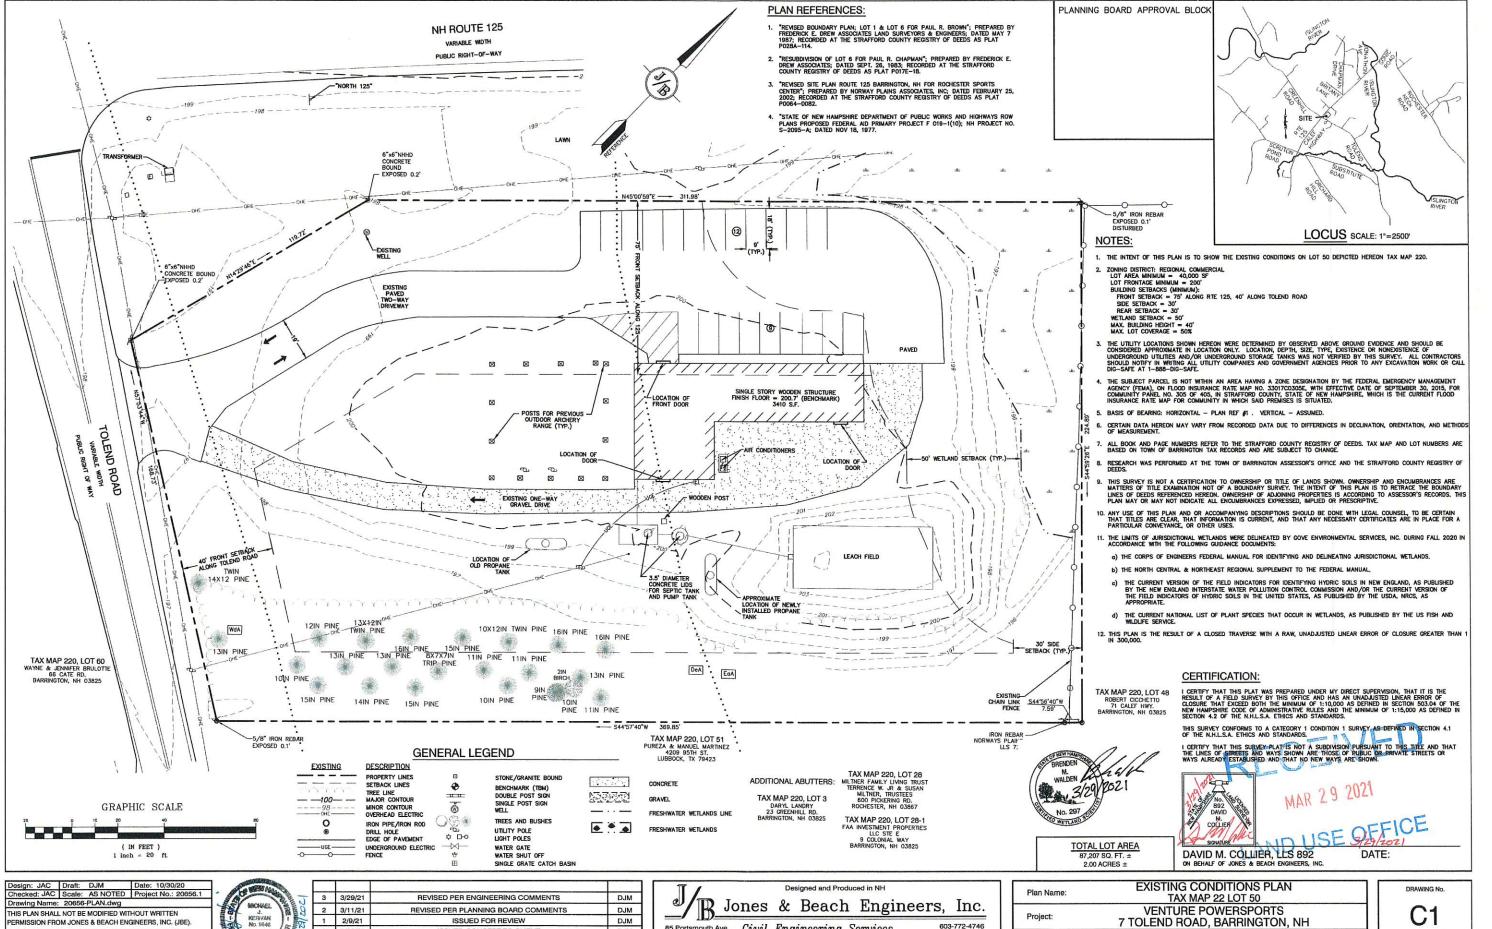
3	3/29/21	REVISED PER ENGINEERING COMMENTS	DJM
2	3/11/21	REVISED PER PLANNING BOARD COMMENTS	DJM
1	2/9/21	ISSUED FOR REVIEW	DJM
0	1/20/21	ISSUED CONCEPT TO CLIENT	DJM
REV.	DATE	REVISION	BY




Plan Name:	COVER SHEET
Project:	VENTURE POWERSPORTS 7 TOLEND ROAD, BARRINGTON, NH

PEH AND SON LLC

CS




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85 Portsmouth Ave. Civil Engineering Services PO Box 219 E-MAIL: JBE@JONESANDBEACH.COM Stratham, NH 03885

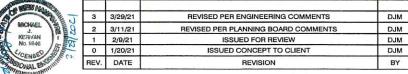Ī	Plan Name:	EXISTING CONDITIONS PLAN TAX MAP 22 LOT 50	
	Project:	VENTURE POWERSPORTS 7 TOLEND ROAD, BARRINGTON, NH	
	Owner of Record:	PEH AND SON, LLC 17 DUDLEY ROAD, BRENTWOOD, NH 03833 BK 4855 PG 0723	

SHEET 2 OF 12 JBE PROJECT NO. 20656.



85 Portsmouth Ave. PO Box 219
Stratham, NH 03885

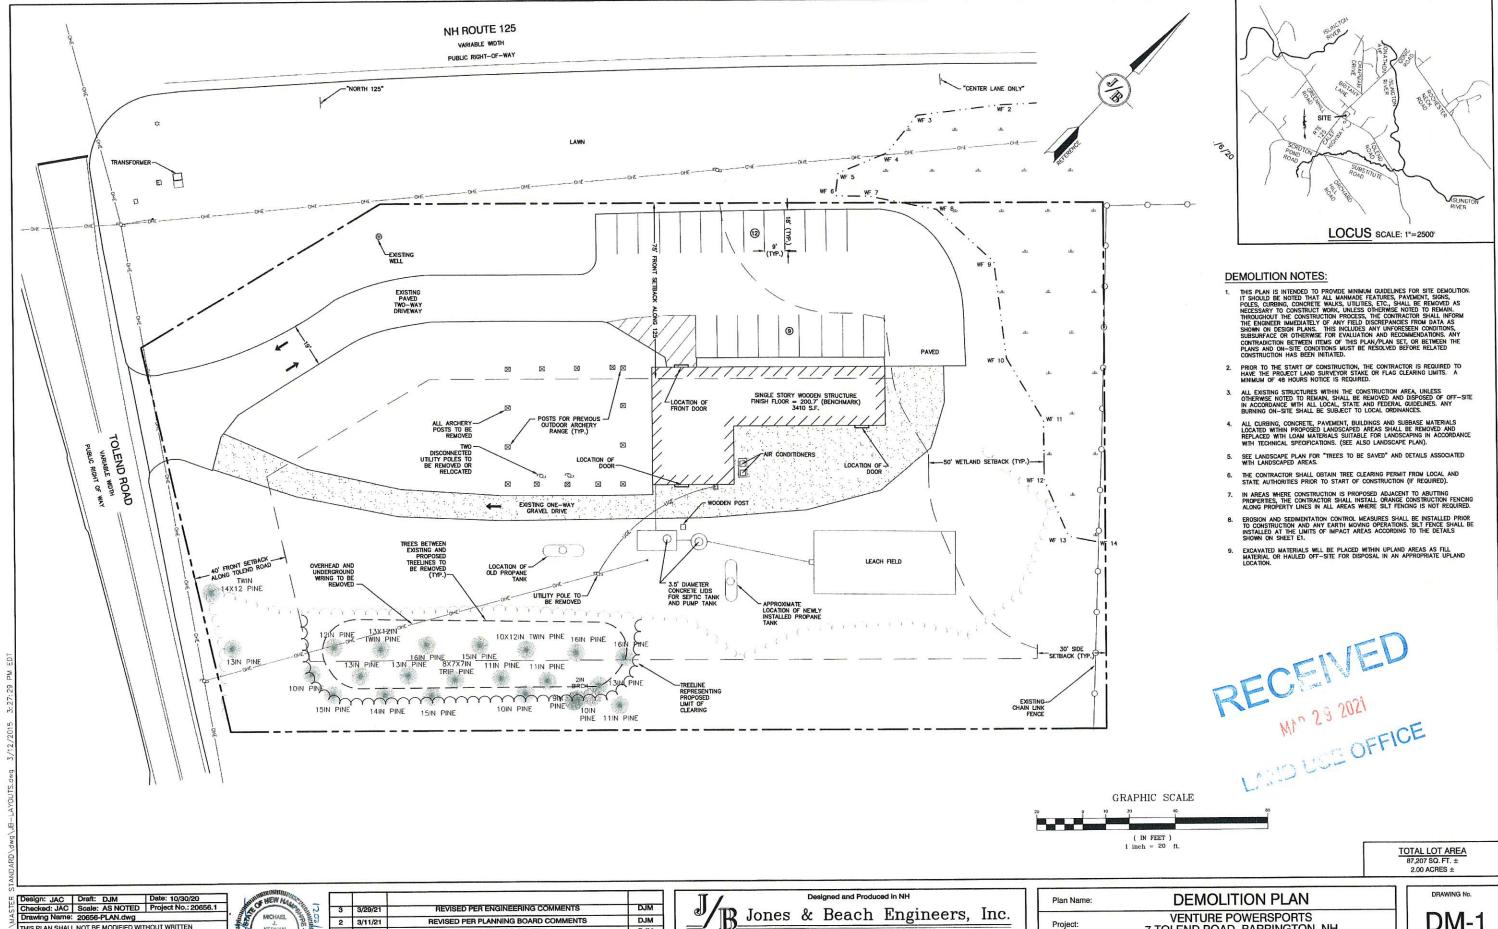E-MAIL: JBE@

FAX: 603-772-0227

E-MAIL: JBE@JONESANDBEACH.COM

Owner of Record:

ISSUED FOR REVIEW

ISSUED CONCEPT TO CLIEN

REVISION

1 2/9/21

0 1/20/21

DJM

DJM

BY


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DM-1 7 TOLEND ROAD, BARRINGTON, NH PEH AND SON, LLC 17 DUDLEY ROAD, BRENTWOOD, NH 03833 BK 4855 PG 0723 SHEET 3 OF 12 JBE PROJECT NO. 20656.1




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0	1/20/21	ISSUED CONCEPT TO CLIENT	DJM
REV.	DATE	REVISION	BY

E-MAIL: JBE@JONESANDBEACH.COM Stratham, NH 03885

17 DUDLEY ROAD, BRENTWOOD, NH 03833 BK 4855 PG 0723

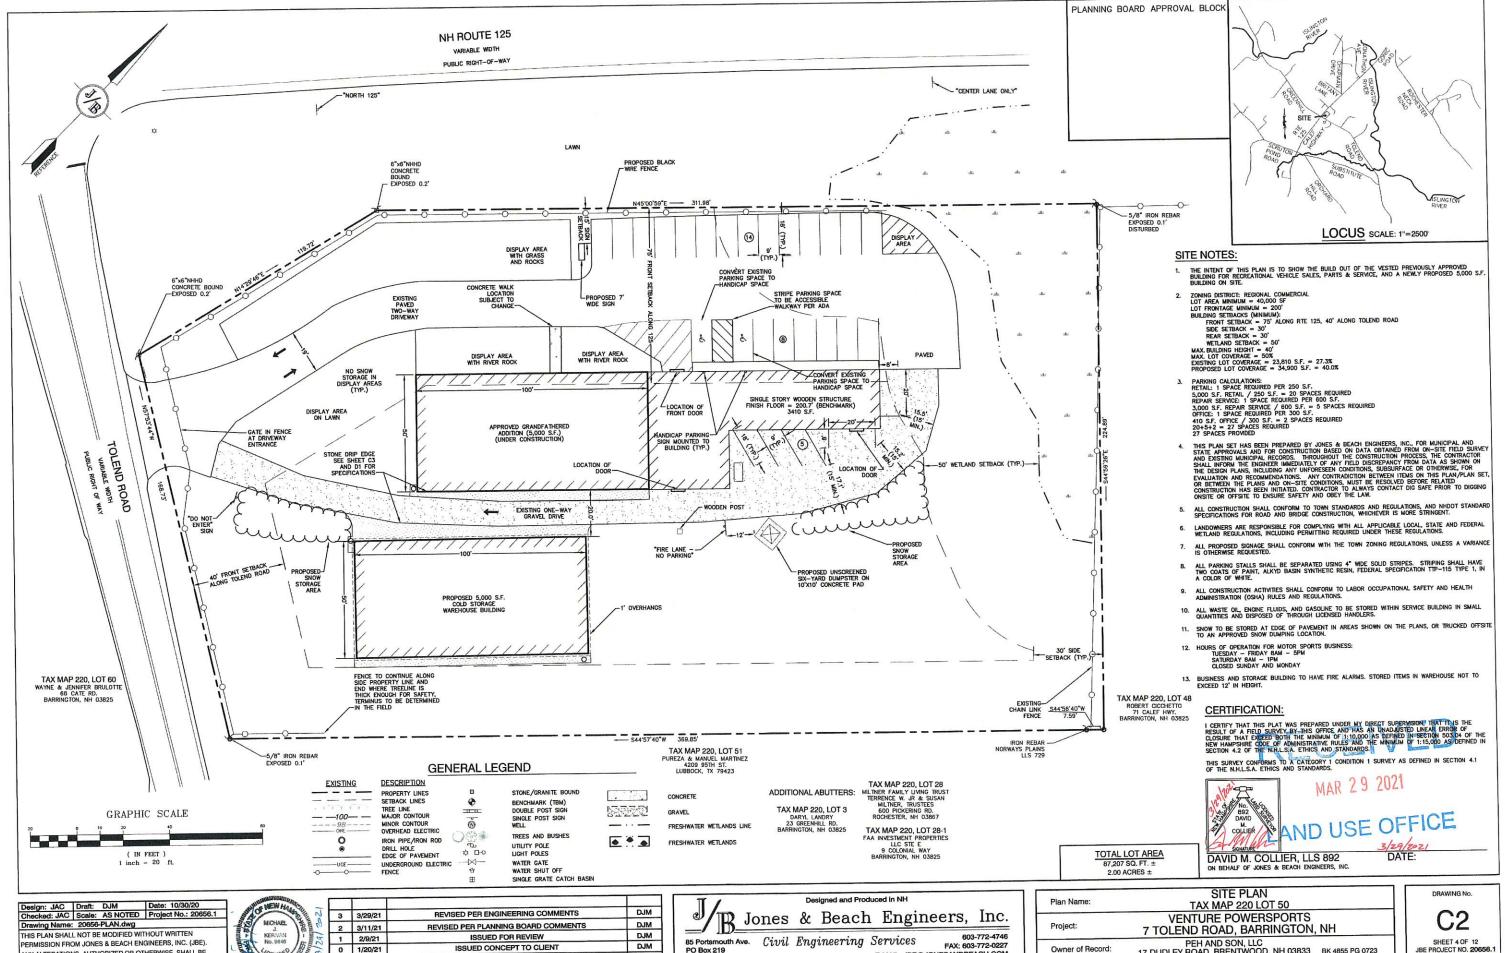

TOTAL LOT AREA 87,207 SQ. FT. ± 2.00 ACRES ±

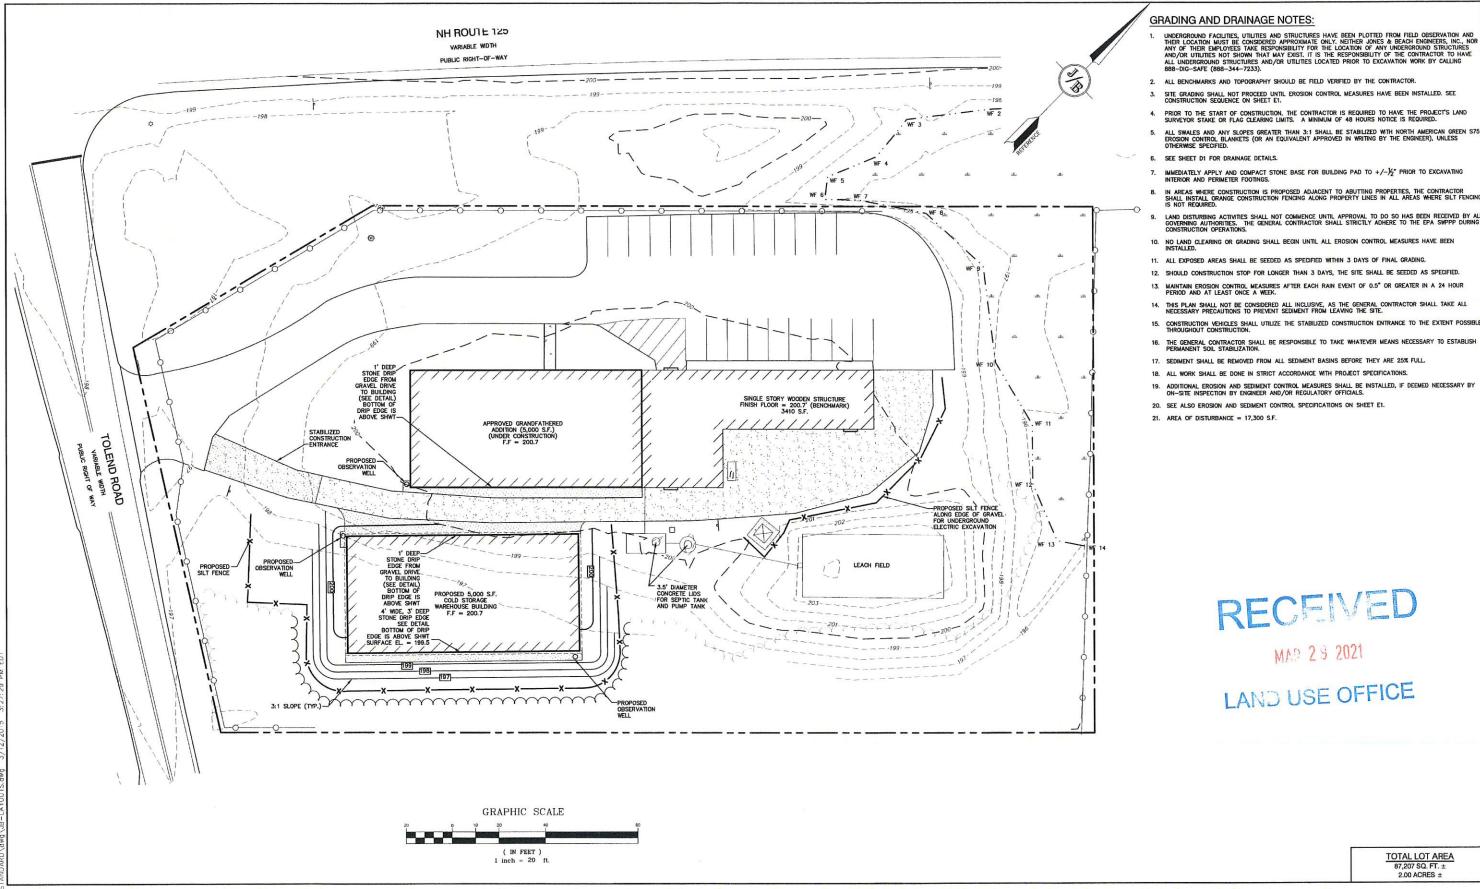Design: JAC Draft: DJM Date: 10/30/20
Checked: JAC Scale: AS NOTED Project No.: 20656.1 Drawing Name: 20656-PLAN.dwg THIS PLAN SHALL NOT BE MODIFIED WITHOUT WRITTEN PERMISSION FROM JONES & BEACH ENGINEERS, INC. (JBE). ANY ALTERATIONS, AUTHORIZED OR OTHERWISE, SHALL BE AT THE USER'S SOLE RISK AND WITHOUT LIABILITY TO JBE.



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Street 7	3	3/29/21	REVISED PER ENGINEERING COMMENTS	DJM
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I ES	1	2/9/21	ISSUED FOR REVIEW	DJM
NEW CO	0	1/20/21	ISSUED CONCEPT TO CLIENT	DJM
Train let.	REV.	DATE	REVISION	BY

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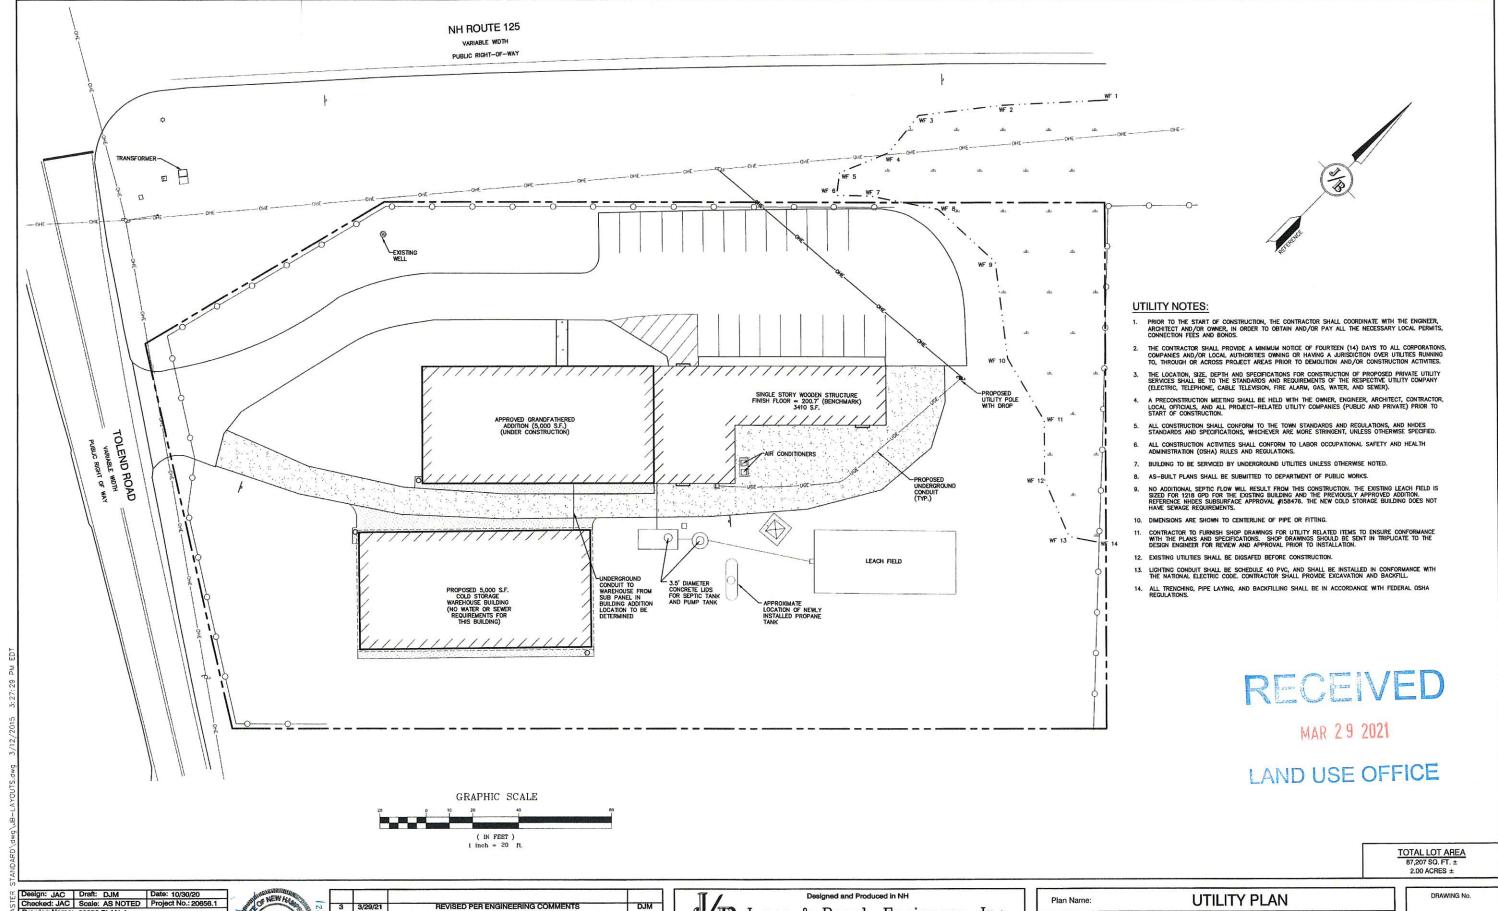
85 Portsmouth Ave. PO Box 219
Stratham, NH 03885

Civil Engineering Services
E-MAIL: JBE@ 603-772-4746 FAX: 603-772-0227 E-MAIL: JBE@JONESANDBEACH.COM

Plan Name:	GRADING AND DRAINAGE PLAN
Project:	VENTURE POWERSPORTS 7 TOLEND ROAD, BARRINGTON, NH

PEH AND SON, LLC 17 DUDLEY ROAD, BRENTWOOD, NH 03833 BK 4855 PG 0723

C3



Design: JAC Draft: DJM Date: 10/30/20
Checked: JAC Scale: AS NOTED Project No.: 20856.1
Drawing Name: 20856-PLAN.dwg
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0	1/20/21	ISSUED CONCEPT TO CLIENT	DJM
REV.	DATE	REVISION	BY

Jones & Beach Engineers, Inc.

B5 Portsmouth Ave. Civil Engineering Services 603-772-4748
PO Box 219
Stretham, NH 03885

603-772-0227
E-MAIL: JBE@JONESANDBEACH.COM


Plan Name:	UTILITY PLAN
Project:	VENTURE POWERSPORTS 7 TOLEND ROAD, BARRINGTON, NH
Owner of Record:	PEH AND SON, LLC 17 DUDLEY ROAD, BRENTWOOD, NH 03833 BK 4855 PG 0723


DRAWING No.

C4

SHEET 6 OF 12

JBE PROJECT NO. 20656.

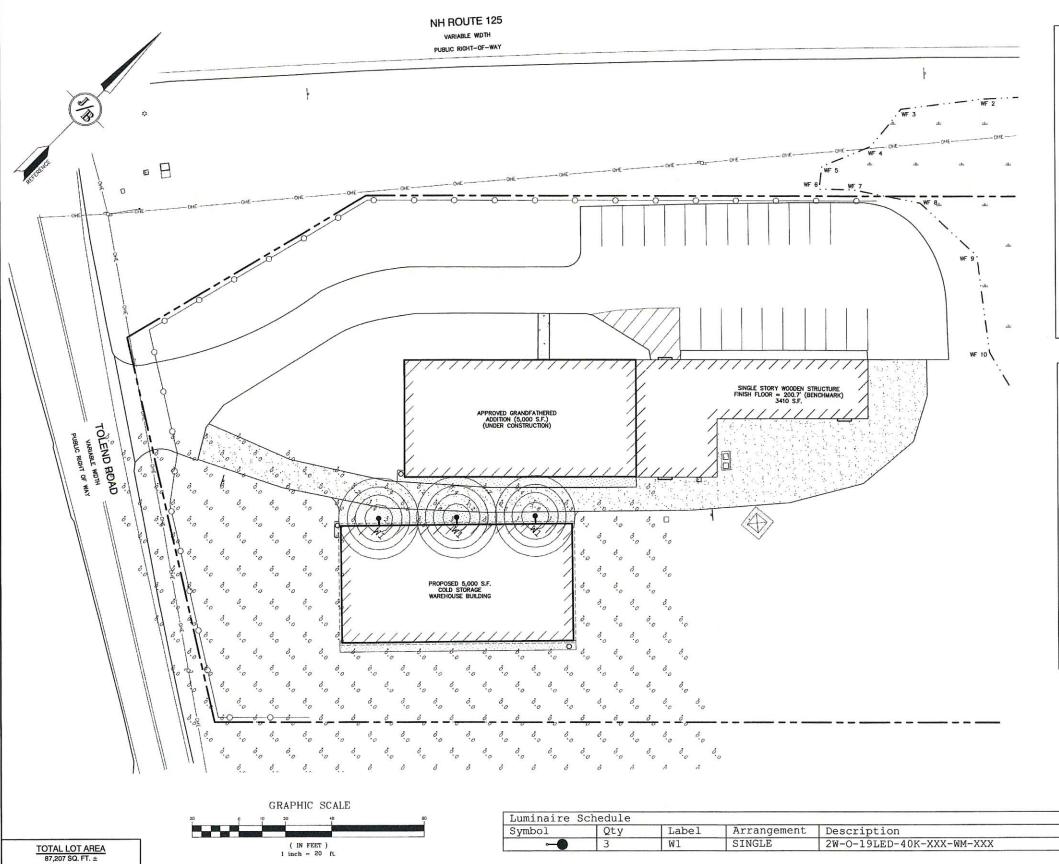

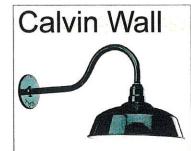

- . Provides excellent coverage and uniformity with cut-off Practical and aesthetic options for application and design flexibility
- Weatherproof construction to withstand the elements
- . Quality components combined with the most current technology for high

Applications
The Calvin wall-mount luminaire is ideal for illuminating areas where localized distribution is necessary, such as doorways and entrances, laneways, pation and could provide adequate night time security lighting. It lends itself to commercial, and inclustrial applications that could benefit from materials and maintenance cost reductions. Calvin could either augment the existing lighting. or illuminate a small to medium-sized area.

Calvin is also available as a pendant-style model

TMSLIGHTING

Construction


High grade spun aluminum, brushed solid copper, or brushed 316L stainless stereflector, with stainless steel mounting hardware, for indoor and outdoor applications

Diffuser
Globe clear and pramatic, clongated, glass globes are available
Lens. the clear, flat lens provides slight diffusion, and proteclocated in the reflector.
Note, GSI is used with 100N, SOCF, and 15LED max.
Only prismatic globes are compatible with LED systems.
Globes are not available with the 17W LED PAR 38 lamps.

Option

Wire Guard: a steel, chrome-plated wire guard is available tight projectiles, wildlife, and serves as a vandal deterrent

.@. **C € IP23**

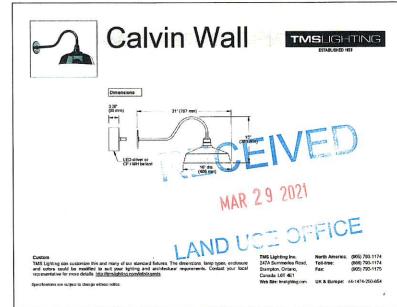

LIGHTING AND ELECTRICAL NOTES:

- THE PROPOSED LIGHTING CALCULATIONS AND DESIGN WAS PERFORMED BY CHARRON, INC., P.G. BOX 4550, MANCHESTER, NH 0.3108, ATTENTION KEN SWEENEY, ALL LIGHTS SHOULD BE PURCHASED FROM THIS COMPANY OR ONE OF THEIR SUPPLIERS, OR AN EQUAL LIGHTING DESIGN SHOULD BE SUBMITTED FOR REMEW IF EQUAL SUBSTITUTIONS ARE PROPOSED BY THE CONTRACTOR OR OWNER.

THIS PLAN SHALL NOT BE MODIFIED WITHOUT WRITTEN PERMISSION FROM JONES & BEACH ENGINEERS, INC. (JBE). ANY ALTERATIONS, AUTHORIZED OR OTHERWISE, SHALL BE AT THE USER'S SOLE RISK AND WITHOUT LIABILITY TO JBE.

2.00 ACRES ±



1 inch = 20 ft.


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	3/11/21 2/9/21 1/20/21	3/11/21 REVISED PER PLANNING BOARD COMMENTS 2/9/21 ISSUED FOR REVIEW 1/20/21 ISSUED CONCEPT TO CLIENT

Designed and Produced in NH **B** Jones & Beach Engineers, Inc. ✓

603-772-4746 FAX: 603-772-0227 85 Portsmouth Ave. Civil Engineering Services E-MAIL: JBE@JONESANDBEACH.COM

Plan Name:	LIGHTING PLAN	
Project:	VENTURE POWERSPORTS 7 TOLEND ROAD, BARRINGTON,	NH
Owner of Record:	PEH AND SON, LLC 17 DUDLEY ROAD, BRENTWOOD, NH 03833	BK 4855 PG 0723

DRAWING No. SHEET 7 OF 12 JBE PROJECT NO. 20656

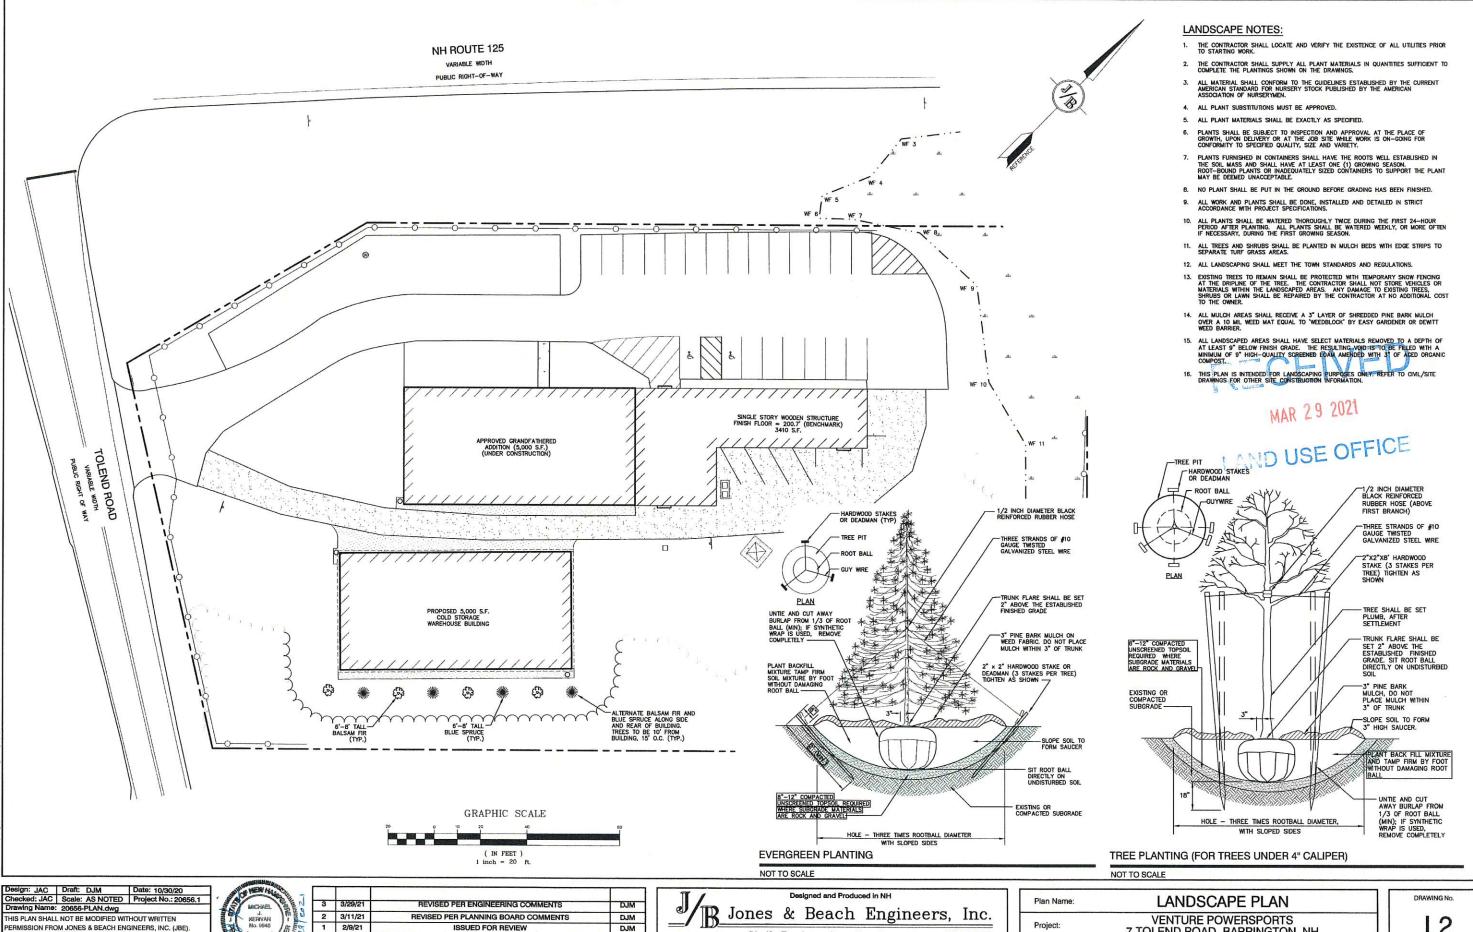

85 Portsmouth Ave. Civil Engineering Services

FAX: 603-772-0227

E-MAIL: JBE@JONESANDBEACH.COM

DJM

BY

PO Box 219 Stratham, NH 03885

ISSUED CONCEPT TO CLIENT

REVISION

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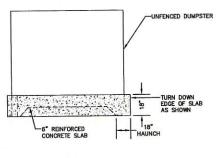
0 1/20/21

REV. DATE

SHEET 8 OF 12


7 TOLEND ROAD, BARRINGTON, NH

PEH AND SON, LLC 17 DUDLEY ROAD, BRENTWOOD, NH 03833 BK 4855 PG 0723



DUMPSTER SLAB PLAN

NOT TO SCALE

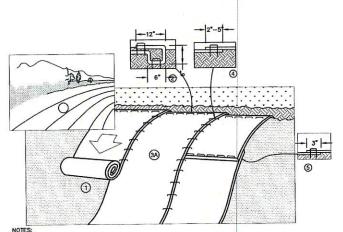

PREPARE SOIL BEFORE INSTALLING BLANKETS, INCLUDING ANY NECESSARY APPLICATION OF LIME, FERTILIZER, AND SEED. NOTE: WHEN USING CELL-O-SEED DO NOT SEED PREPARED AREA. WITH PAPER SIDE DOWN.

2. BEGIN AT THE TOP OF THE SLOPE BY ANCHORING THE BLANKET IN A 6" DEEP BY 6" WIDE TRENCH WITH APPROXIMATELY 12" OF BLANKET EXTENDED BEYOND THE UP-SLOPE PORTION OF THE TRENCH. ANCHOR THE BLANKET WITH A ROW OF STAPLES/STAKES APPROXIMATELY 12" APART IN THE BOTTOM OF THE TRENCH. BLACKFILL AND COMPACTED SOIL AND FOLD REMAINING 12" PORTION OF BLANKET BACK OVER SEED AND COMPACTED SOIL. SECURE BLANKET OVER COMPACTED SOIL WITH A ROW OF STAPLES/STAKES SPACED APPROXIMATELY 12" APART ACROSS THE WIDTH OF THE BLANKET.

3. ROLL THE BLANKETS (A) DOWN OR (B) HORIZONTALLY ACROSS THE SLOPE. BLANKETS WILL UNROLL WITH APPROPRIATE SIDE AGAINST THE SOIL SURFACE. ALL BLANKETS MUST BE SECURELY FASTENED TO SOIL SURFACE BY PLACING STAPLES/STAKES IN APPROPRIATE LOCATIONS AS SHOWN IN THE STAPLE PATTERN GUIDE. WHEN USING OPTIONAL DOT SYSTEMM, STAPLES/STAKES SHOULD BE PLACED THROUGH EACH OF THE COLORED DOTS CORRESPONDING TO THE APPROPRIATE STAPLE PATTERN.

6. THE EDGES OF PARALLEL BLANKETS MUST BE STAPLED WITH APPROXIMATELY 2"-5" OVERLAP DEPENDING ON BLANKET TYPE. TO ENSURE PROPER SEAM ALIGNMENT, PLACE THE EDGE OF THE OVERLAPPING BLANKET (BLANKET BEING INSTALLED ON TOP) EVEN WITH THE COLORED SEAM STITCH ON THE PREVIOUSLY INSTALLED BLANKET.

5. CONSECUTIVE BLANKETS SPLICED DOWN THE SLOPE MUST BE PLACED END OVER END (SHINGLE STYLE) WITH AN APPROXIMATE 3" OVERLAP, STAPLE THROUGH OVERLAPPED AREA, APPROXIMATELY 12" APART ACROSS ENTIRE BLANKET WIDTH. NOTE: IN LOOSE SOIL CONDITIONS, THE USE OF STAPLE OR STAKE LENGTHS GREATER THAN 6" MAY BE NECESSARY TO PROPERLY SECURE THE BLANKETS.



EROSION CONTROL BLANKET SLOPE INSTALLATION (North American Green)

NOT TO SCALE

14649 HIGHWAY 41 NORTH EVANSVILLE, INDIANA 47725

> UTILITY TRENCH NOT TO SCALE

NORTH AMERICAN GREEN 1-800-772-2040

SECTION A-A

-BUILDING MOUNTED SIGN WITH ACCESSIBILITY SYMBOL AND 'VAN ACCESSIBLE' SIGN BELOW (TYP.) ACCESSIBILITY SYMBOL PAINTED ON PAVEMENT WHITE FIGURE ON BLUE BACKGROUND 4" PAINTED STRIPING 1'-6" O.C. AT 45' IN FRONT OF RAMP (YELLOW REFLECTIVE) PAVEMENT MAXIMUM SLOPE 2% IN ALL DIRECTIONS.

96" MIN. PER | 60" MIN. | 96" MIN. PER

A.D.A. OR PER PER A.D.A. A.D.A. OR PER LOCAL CODE OR AS SHOWN LOCAL CODE

PARKING ONLY

VAN

ACCESSIBLE

PARTIAL ELEVATION


HANDICAP PARKING LAYOUT

NOT TO SCALE

LAND USE OFFICE CAP WITH LOCK-OBSERVATION WELL 4" PERFORATED PVC PIPE LOCATION PER SHEET C3-AMOCO 2016 GEOTEXTILE ON BOTTOM AND SIDES OF OPEN-GRADED BASE


DRIP EDGE INFILTRATION DETAIL

NOT TO SCALE

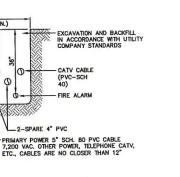

NOTE: ALL UTILITIES SHALL BE REVIEWED AND APPROVED BY APPROPRIATE UTILITY COMPANY.

HANDICAP SIGN DETAILS

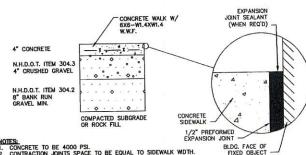

OTES. ÉXPANSION J.
CONCRETE TO BE 4000 PSI.
CONTRACTION JOINTS SPACE TO BE EQUAL TO SIDEWALK WIDTH.
ALL JOINTS SEALED PER SPECIFICATIONS.
PROMDE A 1/2" NON-EXTRUDINC EXPANSION JOINT AGAINST STRUCTURE
AND EVERY 16" ALONG SIDEWALK.

CONCRETE WALKWAY

NOT TO SCALE

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0	1/20/21	ISSUED CONCEPT TO CLIENT	DJM
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PLASTIC MARKER TAPE ABOVE CABLES

Designed and Produced in NH Jones & Beach Engineers, Inc.

MOUNTING

85 Portsmouth Ave. Civil Engineering Services
PO Box 219
Stratham, NH 03885
E-MAIL: JBE@ Detruces FAX: 603-772-0227 E-MAIL: JBE@JONESANDBEACH.COM

-NUT AND LOCK WASHE

Plan Name:	DETAIL SHEET	
Project:	VENTURE POWERSPORTS 7 TOLEND ROAD, BARRINGTON,	NH
Owner of Record:	PEH AND SON, LLC 17 DUDLEY ROAD, BRENTWOOD, NH 03833	BK 4855 PG 0723

DRAWING No. SHEET 9 OF 12 JBE PROJECT NO. 20656.1

NOT TO SCALE

COLD STORAGE AREA 4,850 S.F. ± MAR 29 2021 LAND USE OFFICE FLOOR PLAN FOR PROPOSED BUILDING 1/4" = 1'-0" Design: JAC Draft: DJM Date: 10/80/20 Checked: JAC Scale: AS NOTED Project No.: 20656.1 Drawing Name: 20656-PLAN.dwg Designed and Produced in NH FLOOR PLAN Plan Name: 3 3/29/21 REVISED PER ENGINEERING COMMENTS DJM B Jones & Beach Engineers, Inc. VENTURE POWERSPORTS 7 TOLEND ROAD, BARRINGTON, NH DJM **A1** 2 3/11/21 1 2/9/21 REVISED PER PLANNING BOARD COMMENTS THIS PLAN SHALL NOT BE MODIFIED WITHOUT WRITTEN PERMISSION FROM JONES & BEACH ENGINEERS, INC. (JBE). ANY ALTERATIONS, AUTHORIZED OR OTHERWISE, SHALL BE Project: DJM Services 603-772-4746 FAX: 603-772-0227 E-MAIL: JBE@JONESANDBEACH.COM ISSUED FOR REVIEW

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PO Box 219
Stratham, NH 03885
E-MAIL: JBE@.

SHEET 10 OF 12 JBE PROJECT NO. **20656.1**

PEH AND SON, LLC 17 DUDLEY ROAD, BRENTWOOD, NH 03833 BK 4855 PG 0723

Owner of Record:

DJM

BY


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REVISION

0 1/20/21


REV. DATE

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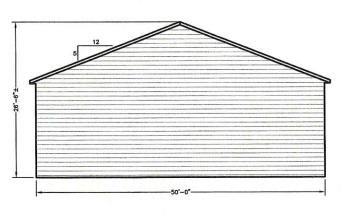
SOUTHWEST ELEVATION

1/8" = 1'-0"

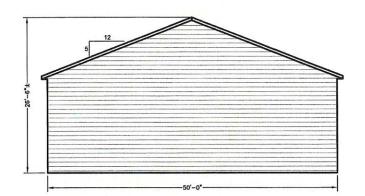


NORTHWEST ELEVATION

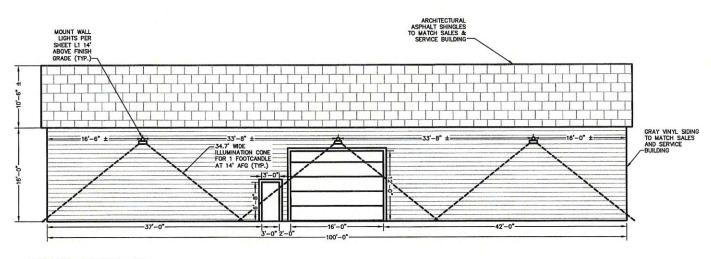1/8" = 1'-0"



NORTHEAST ELEVATION

1/8" = 1'-0"

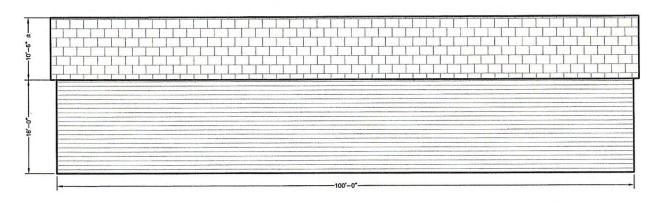

SOUTHEAST ELEVATION

1/8" = 1'-0"

RECEIVED

MAR 29 2021

"ID UCE OFFICE

Design: JAC Draft: DJM Date: 10/30/20
Checked: JAC Scale: AS NOTED Project No.: 20656.1
Drawing Name: 20656-PLAN.dwg
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REV.	DATE	REVISION	BY

11	Designed and Produced in NH					
B Jo	nes	&	Beach	ı Engi	neers,	Inc.
85 Portsmouth Ave. PO Box 219 Stratham, NH 03885	Civil	Eng	ineering		603 FAX: 603 @JONESANDBE	3-772-4746 3-772-0227 ACH.COM

Plan Name:	ARCHITECTURAL ELEVATION	NS	
Project:	VENTURE POWERSPORTS 7 TOLEND ROAD, BARRINGTON,	NH	
Owner of Record:	PEH AND SON, LLC 17 DUDLEY ROAD, BRENTWOOD, NH 03833	BK 4855 PG 0723	

DRAWING No.

A2
SHEET 11 OF 12
JBE PROJECT NO. 20656.7

TEMPORARY EROSION CONTROL NOTES

- THE SMALLEST PRACTICAL AREA OF LAND SHALL BE EXPOSED AT ANY ONE TIME. AT NO TIME SHALL AN AREA IN EXCESS OF 5 ACRES BE EXPOSED AT ANY ONE TIME BEFORE DISTURBED AREAS ARE STABILIZED,
- Erosion, sediment and detention measures shall be installed as shown on the plans and at locations as required, directed by the engineer.
- ALL DISTURBED AREAS (INCLUDING POND AREAS BELOW THE PROPOSED WATERLINE) SHALL BE RETURNED TO PROPOSED GRADES AND ELEVATIONS. DISTURBED AREAS SHALL BE LOAMED WITH A MINIMUM OF 6" OF SCREENED ORGANIC LOAM AND SEEDED WITH SEED MIXTURE" OF AT A RATE NOT LESS THAN 1.10 POUNDS OF SEED PER 1,000 S.F. OF AREA (48 LBS. / AORE.)
- SILT FENCES AND OTHER BARRIERS SHALL BE INSPECTED EVERY SEVEN CALENDAR DAYS AND WITHIN 24 HOURS OF A RAINFALL OF 0.5" OR GREATER. ALL DAMAGED AREAS SHALL BE REPAIRED, AND SEDIMENT DEPOSITS SHALL PERIODICALLY BE REMOVED AND DISPOSED OF.
- AFTER ALL DISTURBED AREAS HAVE BEEN STABILIZED, THE TEMPORARY EROSION CONTROL MEASURES SHALL BE REMOVED AND THE AREA DISTURBED BY THE REMOVAL SMOOTHED AND RE-VEGETATED.
- AREAS MUST BE SEEDED AND MULCHED OR OTHERWISE PERMANENTLY STABILIZED WITHIN 3 DAYS OF FINAL GRADING, OR TEMPORARILY STABILIZED WITHIN 14 DAYS OF THE INITIAL DISTURBANCE OF SOIL. ALL AREAS SHALL BE STABILIZED WITHIN 45 DAYS OF INITIAL DISTURBANCE.
- ALL PROPOSED VECETATED AREAS THAT DO NOT EXHIBIT A MINIMUM OF 85 PERCENT VECETATIVE GROWTH BY OCTOBER 15, OR WHICH ARE DISTURBED AFTER OCTOBER 15, SHALL BE STABILIZED BY SEEDING AND INSTALLING NORTH AMERICAN GREEN 575 PERSISION CONTROL BLANKETS (OR AM EQUIVALENT APPROVED IN WRITING BY THE ENGINEER) ON SLOPES GREATER THAN 3:1, AND SEEDING AND PLACING 3 TO 4 TONS OF MULCH PER ACRE, SECURED WITH ANCHORED NETTING, ELSEWHERE. THE INSTALLATION OF EROSION CONTROL BLANKETS OR MULCH AND NETTING SHALL NOT OCCUR OVER ACCUMULATED SNOW OR ON FROZEN GROUND AND SHALL BE COMPLETED IN ADVANCE OF THAW OR SPRING MELT EVENTS.
- ALL DITCHES OR SWALES WHICH DO NOT EXHIBIT A MINIMUM OF 85 PERCENT VEGETATIVE GROWTH BY OCTOBER 15, OR WHICH ARE DISTURBED AFTER OCTOBER 15, SHALL BE STABILIZED TEMPORARILLY WITH STONE OR EROSION CONTROL BLANKETS APPROPRIATE FOR THE DESIGN FLOW CONDITIONS.
- AFTER OCTOBER 15th, INCOMPLETE ROAD OR PARKING SURFACES, WHERE WORK HAS STOPPED FOR THE WINTER SEASON, SHALL BE PROTECTED WITH A MINIMUM OF 3" OF CRUSHED GRAVEL PER NHDOT ITEM 304.3.
- AN AREA SHALL BE CONSIDERED STABLE IF ONE OF THE FOLLOWING HAS OCCURRED.
 - a. BASE COURSE GRAVELS HAVE BEEN INSTALLED IN AREAS TO BE PAVED
 - b. A MINIMUM OF 85% VEGETATED GROWTH HAS BEEN ESTABLISHED:
 - c. A MINIMUM OF 3" OF NON-EROSIVE MATERIAL SUCH STONE OR RIPRAP HAS BEEN INSTALLED; OR
- d. EROSION CONTROL BLANKETS HAVE BEEN PROPERLY INSTALLED.
- FUGITIVE DUST CONTROL IS REQUIRED TO BE CONTROLLED IN ACCORDANCE WITH ENV-A 1000, AND THE PROJECT IS TO MEET THE REQUIREMENTS AND INTENT OF RSA 430:53 AND AGR 3800 RELATIVE TO INVASIVE SPECIES.

AREA OF EMBANKMENT CONSTRUCTION OR ANY DISTURBED AREA TO BE EOTEXTILE FENCE WITH PROPEX-SILT STOP SEDIMENT CONTROL FABRIC OR

- . WOVEN FABRIC FENCE TO BE FASTENED SECURELY TO FENCE POSTS WITH WIRE TIES OR STAPLES. FILTER CLOTH SHALL BE FASTENED TO WOVEN WIRE EVERY 24° AT TOP, MID AND BOTTOM AND EMBEDDED IN THE GROUND A MINIMUM OF 8° AND THEN COVERED WITH SOIL.
- THE FENCE POSTS SHALL BE A MINIMUM OF 48" LONG, SPACED A MAXIMUM 10' APART, AND DRIVEN A MINIMUM OF 16" INTO THE GROUND.
- MAINTENANCE SHALL BE PERFORMED AS NEEDED AND SEDIMENT REMOVED AND PROPERLY DISPOSED OF WHEN IT IS 6" DEEP OR VISIBLE 'BULGES' DEVELOP IN THE SILT FENCE.
- 5. PLACE THE ENDS OF THE SILT FENCE UP CONTOUR TO PROVIDE FOR SEDIMENT STORAGE
- 6. SILT FENCE SHALL REMAIN IN PLACE FOR 24 MONTHS.

THIS PLAN SHALL NOT BE MODIFIED WITHOUT WRITTEN

PERMISSION FROM JONES & BEACH ENGINEERS, INC. (JBE).

ANY ALTERATIONS, AUTHORIZED OR OTHERWISE, SHALL BE

AT THE USER'S SOLE RISK AND WITHOUT LIABILITY TO JBE.

SILT FENCE

NOT TO SCALE



3	3/29/21	REVISED PER ENGINEERING COMMENTS	DJN
2	3/11/21	REVISED PER PLANNING BOARD COMMENTS	DJM
1	2/9/21	ISSUED FOR REVIEW	DJN
0	1/20/21	ISSUED CONCEPT TO CLIENT	DJN
REV.	DATE	REVISION	BY

DISTURBED AREA (UPHILL) ~

MAINTENANCE:

CONTOUR LINES 600' RECOMMENDED MAXIMUM

FLARE ENDS UPHILL TO PROVIDE TRAPPING CAPABILITY AND SEDIMENT STORAGE AREA

SILT FENCES SHALL BE REMOVED WHEN NO LONGER NEEDED AND THE SEDIMENT COLLECTED SHALL BE DISPOSED AS DIRECTED BY THE ENGINEER. THE AREA DISTURBED BY THE REMOVAL SHALL BE SMOOTHED AND REVEGETATED.

SILT FENCES SHALL BE INSPECTED IMMEDIATELY AFTER EACH RAINFALL AND AT LEAST DAILY DURING PROLONGED RAINFALL. ANY REPAIRS THAT ARE REQUIRED SHALL BE DONE IMMEDIATELY.

IF THE FABRIC ON A SILT FENCE SHOULD DECOMPOSE OR BECOME INEFFECTIVE DURING THE EXPECTED LIFE OF THE FENCE, THE FABRIC SHALL BE REPLACED PROMPTLY.

SEDIMENT DEPOSITS SHOULD BE INSPECTED AFTER EVERY STORM EVENT. THE DEPOSITS SHOULD BE REMOVED WHEN THEY REACH APPROXIMATELY ONE HALF THE HEIGHT OF THE BARRIER.

SEDIMENT DEPOSITS THAT ARE REMOVED, OR LEFT IN PLACE AFTER THE FABRIC HAS BEEN REMOVED, SHALL BE GRADED TO CONFORM WITH THE EXISTING TOPOGRAPHY AND VEGETATED.

FENCING IS TO RUN WITH THE CONTOURS ACROSS A SLOPE

SEEDING SPECIFICATIONS

- I. GRADING AND SHAPING

 A. SLOPES SHAPING

 A. SLOPES SHAPING THAN 2:1 WITHOUT APPROPRIATE EROSION CONTROL MEASURES AS SPECIFIED ON THE PLANS (3:1 SLOPES OR FLATTER ARE PREFERRED).

 B. WHERE MOWING WILL BE DONE, 3:1 SLOPES OR FLATTER ARE RECOMMENDED.

- SEEDBED PREPARATION
 A. SURFACE AND SEPAGE WATER SHOULD BE DRAINED OR DIVERTED FROM THE SITE TO PREVENT DROWNING OR WINTER KILLING OF THE PLANTS.

 STONES LARGER THAN 4 INCHES AND TRASH SHOULD BE REMOVED BECAUSE THEY INTERFERE WITH SEEDING AND FUTURE MAINTENANCE OF THE AREA. WHERE FEASIBLE, THE SOIL SHOULD BE TILLED TO A DEPTH OF ABOUT 4 INCHES TO PREPARE A SEEDBED AND FERTILIZER AND LINE MIXED INTO THE SOIL THE SEEDBED SHOULD BE LEFT IN A REASONABLY FIRM AND SMOOTH CONDITION. THE LAST TILLAGE OPERATION SHOULD BE PERFORMED ACROSS THE SLOPE WHEREVER PRACTICAL.

- 3. <u>Establishing a Stand</u>

 A. Lime and Fertilizer should be appued prior to or at the time of seeding and incorporated into the soil. Types and amounts of lime and Fertilizer should be based on an evaluation of soil tests. When a soil test is not available, the following minimum amounts should be
 - APPLIED: AGRICULTURAL LIMESTONE, 2 TONS PER ACRE OR 100 LBS. PER 1,000 SQ.FT. NITROCEN(N), 50 LBS. PER ACRE OR 1.1 LBS. PER 1,000 SQ.FT.

 PHOSPHATE(P205), 100 LBS. PER ACRE OR 2.2 LBS. PER 1,000 SQ.FT.

 POTASH(K2O), 100 LBS. PER ACRE OR 2.2 LBS. PER 1,000 SQ.FT.
 - (NOTE: THIS IS THE EQUIVALENT OF 500 LBS. PER ACRE OF 10-20-20 FERTILIZER OR 1,000 LBS. PER
- SECD SHOULD BE SPREAD UNIFORMLY BY THE METHOD MOST APPROPRIATE FOR THE SITE. METHODS INCLUDE BROADCASTING, BRILLING AND HYDROSEDING, WHERE BROADCASTING IS USED, COVER SEED WITH ... 25 INCH OF SOLIC OR LESS, BY CULTIPACKING OR RAWING.
- .25 INCH OF SOIL OR LESS, BY CULTIPACKING OR RAKING.
 REFER TO THE 'SEEDING GUIDE' AND 'SEEDING RATES' TABLES ON THIS SHEET FOR APPROPRIATE SEED
 MIXTURES AND RATES OF SEEDING. ALL LEGUMES (CROIN-NETGH, BIRDSFOOT, TREFOIL AND FLATPEA)
 MUST BE INCOLILATED WITH THEIR SPECIFIC INCOLLANT PRIOR TO THEIR INTRODUCTION TO THE SITE.
 WHEN SEEDED AREAS ARE MULCHED, PLANTINGS MAY BE MADE FROM EARLY SPRING TO EARLY OCTOBER.
 WHEN SEEDED AREAS ARE MULCHED, PLANTINGS SHOULD BE MADE FROM EARLY SPRING TO MAY 20th
 OR FROM AUGUST 10th TO SEPTEMBER 1st.

- MULCH
 A. HAY, STRAW, OR OTHER MULCH, WHEN NEEDED, SHOULD BE APPLIED IMMEDIATELY AFTER SEEDING.
 B. MULCH WILL BE HELD IN PLACE USING APPROPRIATE TECHNIQUES FROM THE BEST MANAGEMENT PRACTICE
 FOR MULCHING. HAY OR STRAW MULCH SHALL BE PLACED AT A RATE OF 90 LBS PER 1000 S.F.
- 5. <u>Maintenance to Establish a Stand</u>
 A. <u>Planted Areas should be protected from Damage By Fire, Grazing, Traffic, and Dense Weed</u>
- A PLANTED AREAS STOLD SET THE STANDING TO THE STAND BECAUSE MOST PERMILIZATION NEEDS SHOULD BE DETERMINED BY ONSITE INSPECTIONS. SUPPLEMENTAL FERTILIZER IS USUALLY THE KEY TO FULLY COMPLETE THE ESTABLISHMENT OF THE STAND BECAUSE MOST PERENNIALS TAKE 2 TO 3 YEARS TO BECOME FULLY ESTABLISHED.

 C. IN WATERWAYS, CHANNIELS, OR SWALES WHERE UNIFORM FLOW CONDITIONS ARE ANTICIPATED, ANNUAL MOWING MAY BE NECESSARY TO CONTROL GROWTH OF WOODY VEGETATION.


USE	SEEDING MIXTURE 1/	DROUGHTY	WELL DRAINED	MODERATELY WELL DRAINED	POORLY DRAINED
STEEP CUTS AND	A	FAIR	GOOD	GOOD	FAIR
FILLS, BORROW	B	POOR	GOOD	FAIR	FAIR
AND DISPOSAL AREAS	С	POOR	GOOD	EXCELLENT	GOOD
SIDE WIND	D	FAIR	EXCELLENT	EXCELLENT	POOR
WATERWAYS, EMERGENCY		GOOD	GOOD	GOOD	FAIR
SPILLWAYS, AND OTHER CHANNELS WITH FLOWING WATER.	С	GOOD	EXCELLENT	EXCELLENT	FAIR
LIGHTLY USED PARKING	A	GOOD	GOOD	GOOD	FAIR
LOTS, ODD AREAS,	B	GOOD	GOOD	FAIR	POOR
UNUSED LANDS, AND LOW INTENSITY USE RECREATION SITES.	С	GOOD	EXCELLENT	EXCELLENT	FAIR
PLAY AREAS AND	E	FAIR	EXCELLENT	EXCELLENT	2/
ATHLETIC FIELDS, (TOPSOIL IS ESSENTIAL FOR GOOD TURF.)	F	FAIR	EXCELLENT	EXCELLENT	2/

1/ REFER TO SEEDING MIXTURES AND RATES IN TABLE BELOW.
2/ POORLY DRAINED SOILS ARE NOT DESIRABLE FOR USE AS PLAYING AREA AND ATHLETIC FIELDS. NOTE: TEMPORARY SEED MIX FOR STABILIZATION OF TURF SHALL BE WINTER RYE OR OATS AT A RATE OF 2.5 LBS. PER 1000 S.F. AND SHALL BE PLACED PRIOR TO OCTOBER 15th, IF PERMANENT SEEDING NOT YET COMPIET.

SEEDING GUIDE

NDS POUNDS ACRE 1.000 Sq	
20 0.45	
20 0.45	il)
2 0.05	
42 0.95	
15 0.35	
10 0.25	
15 0.35	
30 0.75	
OR 55 0.95 OR 1.	
20 0.45	\neg
20 0.45	
8 0.20	_
48 1.10	
20 0.45	á
30 0.75	
50 1.20	
50 1.15	
50 1.15	
00 2.30	Г
150 3.60	i)
	2.00

SEEDING RATES

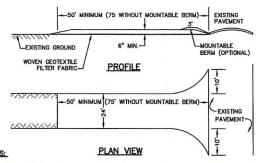

- STONE FOR STABILIZED CONSTRUCTION ENTRANCE SHALL BE 3 INCH STONE, RECLAIMED STONE, OR RECYCLED CONCRETE EQUIVALENT.

- 1. SIONE FOR SIGNIZED CONCRETE EQUIVALENT.

 2. THE LENGTH OF THE STABILIZED ENTRANCE SHALL NOT BE LESS THAN 50 FEET, 75' WITHOUT A MOUNTABLE BERM, AND EXCEPT FOR A SINGLE RESIDENTIAL LOT WHERE A 30 FOOT MINIMUM LENGTH MOUNTABLE BERM, AND EXCEPT FOR A SINGLE RESIDENTIAL LOT WHERE A 30 FOOT MINIMUM LENGTH MOUNTABLE BERM, AND EXCEPT FOR A SINGLE RESIDENTIAL LOT BE LESS THAN THE FULL WIDTH OF THE ENTRANCE WHERE INCRESS OR EGRESS OCCURS, OR 10 FEET, WHICKEVER IS GREATER.

 1. THE WIDTH OF THE ENTRANCE SHALL BE PLACED OVER THE ENTRE AREA PRIOR TO PLACING THE STONE. FILTER FABRIC IS NOT REQUIRED FOR A SINGLE FAMILY RESIDENTIAL LOT.

 2. GEDIENTLE FILTER FABRIC SHALL BE PLACED OVER THE ENTRE AREA PRIOR TO PLACING THE STONE. FILTER FABRIC IS NOT REQUIRED FOR A SINGLE FAMILY RESIDENTIAL LOT.

 2. ALL SURFACE WATER THAT IS FLOWING TO OR DIVERTED TOWARD THE CONSTRUCTION ENTRANCE SHALL BE PIPED BENEATH THE ENTRANCE. IF PIPING IS IMPRACTICAL, A STONE BERM WITH 5:1 SLOPES THAT CAN BE CROSSED BY VEHICLES MAY BE SUBSTITUTED FOR THE PIPE.

 2. THE ENTRANCE SHALL BE MAINTAINED IN CONDITION THAT WILL PREVENT TRACKING OR FLOWING OF SEDIMENT ONTO THE PUPIL CRIGHT—OF—WAY, THIS MAY REQUIRE PERIODIC TOP DRESSING WITH ADDITIONAL STONE AS CONDITIONS DEMAND AND REPAIR AND/OR CLEAN OUT OF ANY MEASURES USED TO TRAP SEDIMENT, ALL SEDIMENT SPILLED, WASHED, OR TRACKED ONTO THE PUPILC RIGHT—OF—WAY WIST BE REMOVED PROMPTLY.

STABILIZED CONSTRUCTION ENTRANCE

NOT TO SCALE

MAR 29 2021 LAND USE OFFICE

CONSTRUCTION SEQUENCE

PRIOR TO THE START OF ANY ACTIVITY, IT IS THE RESPONSIBILITY OF THE SITE'S SITE DEVELOPER (OR OWNER) TO FILE A NOTICE OF INTENT (NOI) FORM WITH THE ENWRONMENTAL PROTECTION AGENCY (EPA) IN ORDER TO GAIN COVERAGE UNDER THE NPDES GENERAL PERMIT FOR STORM WATER DISCHARGES FROM CONSTRUCTION ACTIVITIES. A PRE CONSTRUCTION MEETING IS TO BE HELD WITH ALL DEPARTMENT HEADS PRIOR TO THE START OF CONSTRUCTION.

- 2. WETLAND BOUNDARIES ARE TO BE CLEARLY MARKED PRIOR TO THE START OF CONSTRUCTION. AT LEAST A TEMPORARY CULVERT OR ROADBED TO BE IN PLACE PRIOR TO THE START OF CONSTRUCTION.
- 3. CUT AND REMOVE TREES IN CONSTRUCTION AREA AS REQUIRED OR DIRECTED.
- INSTALL SILT FENCING, HAY BALES AND CONSTRUCTION ENTRANCES PRIOR TO THE START OF CONSTRUCTION. THESE ARE TO BE MAINTAINED UNTIL THE FINAL PAVEMENT SURFACING AND LANDSCAPING AREAS ARE ESTABLISHED.
- CLEAR, CUT, GRUB AND DISPOSE OF DEBRIS IN APPROVED FACILITIES. THIS INCLUDES ANY REQUIRED DEMOLITION OF EXISTING STRUCTURES, UTILITIES, ETC.
- CONSTRUCT AND/OR INSTALL TEMPORARY SEDIMENT AND/OR DETENTION BASIN(S) AS REQUIRED. THESE FACILITIES SHALL BE INSTALLED AND STABILIZED PRIOR TO DIRECTING RUN-OFF TO THEM.
- STRIP LOAM AND PAVEMENT, OR RECLAIM EXISTING PAVEMENT WITHIN LIMITS OF WORK PER THE RECOMMENDATIONS OF THE PROJECT ENGINEER AND STOCKPILE EXCESS MATERIAL. STABILIZE STOCKPILE AS NECESSARY.
- 8. PERFORM PRELIMINARY SITE GRADING IN ACCORDANCE WITH THE PLANS.
- 9. PREPARE BUILDING PAD(S) TO ENABLE BUILDING CONSTRUCTION TO BEGIN.
- 10. INSTALL THE SEWER AND DRAINAGE SYSTEMS FIRST, THEN ANY OTHER UTILITIES IN ACCORDANCE WITH THE PLAN AND DETAILS. ANY CONFLICTS BETWEEN UTILITIES ARE TO BE RESOLVED WITH THE INVOLVEMENT AND APPROVAL OF THE ENGINEER.
- 12. DAILY, OR AS REQUIRED, CONSTRUCT TEMPORARY BERMS, DRAINAGE DITCHES, CHECK DAMS, SEDIMENT TRAPS, ETC., TO PREVENT EROSION ON THE SITE AND PREVENT ANY SILTATION OF ABUTTING WATERS AND/OR PROPERT
- 13. PERFORM FINAL FINE GRADING, INCLUDING PLACEMENT OF 'SELECT' SUBGRADE MATERIALS.
- 14. PAVE ALL PARKING LOTS AND ROADWAYS WITH INITIAL 'BASE COURSE'
- 15. PERFORM ALL REMAINING SITE CONSTRUCTION (I.e. BUILDING, UTILITY CONNECTIONS, ETC.).
- LOAM AND SEED ALL DISTURBED AREAS AND INSTALL ANY REQUIRED SEDIMENT AND EROSION CONTROL FACILITIES (I.e. RIP RAP, EROSION CONTROL BLANKETS, ETC.).
- 17. FINISH PAVING ALL ROADWAYS AND PARKING AREAS WITH 'FINISH' COURSE.
- 18. ALL ROADWAYS AND PARKING LOTS SHALL BE STABILIZED WITHIN 72 HOURS OF ACHIEVING FINISHED GRADE
- 19. ALL CUT AND FILL SLOPES SHALL BE SEEDED/LOAMED WITHIN 72 HOURS OF ACHIEVING FINISHED GRADE.
- REMOVE TEMPORARY EROSION CONTROL MEASURES AFTER SEEDING AREAS HAVE BEEN 75%-85% ESTABLISHED AND SITE IMPROVEMENTS ARE COMPLETE. SMOOTH AND RE-VEGETATE ALL DISTURBED AREAS.
- 22. CLEAN SITE AND ALL DRAINAGE STRUCTURES OF ALL SILT AND DEBRIS
- 23. INSTALL ALL PAINTED PAVEMENT MARKINGS AND SIGNAGE PER THE PLANS AND DETAILS.
- 24. ALL EROSION CONTROLS SHALL BE INSPECTED WEEKLY AND AFTER EVERY HALF-INCH OF RAINFALL.
- 25. UPON COMPLETION OF CONSTRUCTION, IT IS THE RESPONSIBILITY OF THE CONTRACTOR TO NOTIFY ANY RELEVANT PERMITTING AGENCIES THAT THE CONSTRUCTION HAS BEEN FINISHED IN A SATISFACTORY MANNER.

Plan Name: EROSION AND SEDIMENT CONTROL DETAILS VENTURE POWERSPORTS Project: 7 TOLEND ROAD, BARRINGTON, NH PEH AND SON, LLC 17 DUDLEY ROAD, BRENTWOOD, NH 03833 BK 4855 PG 0723 Owner of Record:

DRAWING No SHEET 12 OF 12 JBE PROJECT NO. 20656

IM IM IM 85 Portsmouth Ave. Civil Engineering Services

Jones & Beach Engineers, Inc.

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